# BROCK MISSION SHELTER

# 217 MURRAY STREET, PETERBOROUGH ONTARIO

LOT 6 AND PART OF LOT 5, WEST OF GEORGE STREET, SOUTH OF MURRAY STREET, REGISTERESRED PLAN No.1, CITY OF PETERBOROUGH, COUNTY OF PETERBOROUGH



SHEET NUMBER	SHEET NAME	ISSUE DATE
SPA		
A-0	COVER PAGE	2016/09/07
A-1	SITE PLAN - EXISTING / DEMO	2016/09/07
A-2	SITE PLAN - PROPOSED	2016/09/07
A-3	SCHEMATIC FLOOR PLANS - GROUND & BASEMENT FLOORS	2016/09/07
A-4	SCHEMATIC FLOOR PLANS - SECOND & THIRD FLOORS	2016/09/07
A-6	EXTERIOR ELEVATIONS	2016/09/07
A-7	EXTERIOR ELEVATIONS	2016/09/07
A-8	BUILDING SECTIONS	2016/09/07
L-1	LANDSCAPE - PLAN	2016/09/07
01	CIVIL - STORMWATER DRAINAGE AREAS	2016/09/07
02	CIVIL - SITE SERVICING AND GRADING PLAN	2016/09/07
03	CIVIL - GENERAL NOTES AND DETAILS	2016/09/07
00	PLAN OF SURVEY	2014/04/22

Area Schedule (Gross	Floor Area)
Level	Area (m2)
Basement F.F. (199.85masl)	680 m²
Ground Floor (204.00masl)	680 m²
Second Floor	540 m²
Third Floor	524 m²
	2,424 m²

1 Concept View - From Murray Street

OWNER

Brock Mission 217 Murray Street Peterborough, Ontario, K9H 2S7 705.748.4766 x 4 Contact: Bill McNabb **ARCHITECT** 

LGA Architectural Partners 533 College Street, Unit 301 Toronto, Ontario M6G 1A8 416.203.7600 x 337 Contact: Allison Janes STRUCTURAL CONSULTANT

Blackwell 19 Duncan Street, Suite 405 Toronto, Ontario M5H 3H1 416.593.5300 Contact: Christian Bellini MECHANICAL/ELECTRICAL CONSULTANT

Lam and Associates Ltd. 160 Applewood Cres, Unit 25 Concord, Ontario 905.660.7670 Contact: Patrick Lam CIVIL CONSULTANT

Engage Engineering 420 George St. North, Suite 207 Peterborough, Ontario, K9H 3R5 705.755.0427 Contact: Aaron Hill LANDSCAPE CONSULTANT

Basterfield & Associates 416 Chambers Street Peterborough, Ontario, K9H 3V1 705.745.3623 Contact: Kim Muzatko kim@basterfield.ca LGA architectural partners

533 College Street, Suite 301 Toronto, Ontario, Canada M6G 1A8 T: 416 203 7600 F: 416 203 3342

NOTE: This drawing is the property of the architect and may not be reproduced used without the expressed consent of the architect. The contractor shall be responsible for checking and verifying all levels and dimensions and shall repo all discrepancies to the architect and obtain clarification prior to commencing

BUILDING PERMIT ISSUANCE SHALL BE SUBJECT TO THE BUILDING PERMIT DRAWINGS NOT BEING IN CONTRAVENTION WITH THESE APPROVED PLAN: AND DRAWINGS INCLUDING, BUT NOT LIMITED TO, THE EXTERIOR DESIGN THE BUILDING AND EXTERIOR BUILDING MATERIALS

#### CONTEXT PLAN:



### ISSUED FOR SITE PLAN APPROVAL

PROJECT

### BROCK MISSION MEN'S SHELTER

217 MURRAY STREET, PETERBOROUGH, ONTARIO

DRAWING TITLE:

COVER PAGE


 PROJECT NO:
 14276

 SCALE:
 1:75

 DRAWN BY:
 AJ

 REVIEWED BY:
 JL

DRAWING N

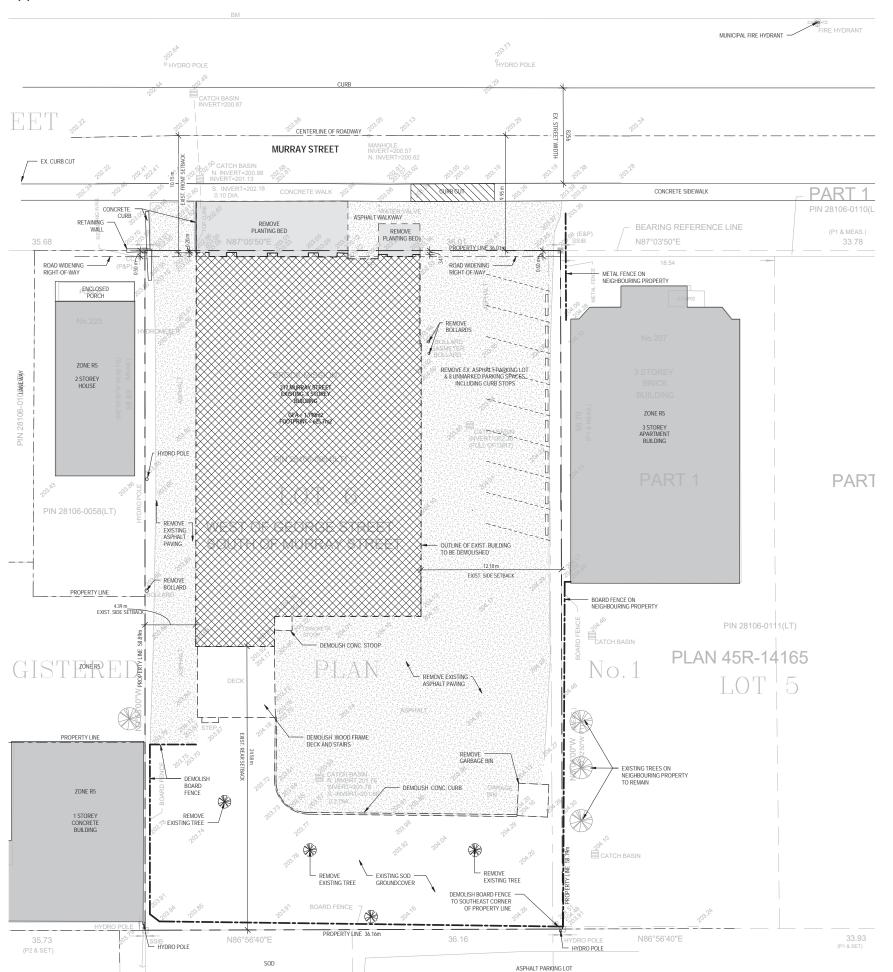



533 College Street, Suite 301 Toronto, Ontario, Canada M6G 1A8 T: 416 203 7600 F: 416 203 3342



### ISSUED FOR SITE PLAN APPROVAL

NO.	DATE	DESCRIPTION
1	2016/01/20	ISSUED FOR COSTING
2	2016/05/09	ISSUED FOR COORDINATION
3	2016/06/07	ISSUED FOR PRE-APPLICATION MTG.
4	2016/09/07	ISSUED FOR SITE PLAN APPROVAL

### **BROCK MISSION** MEN'S SHELTER

217 MURRAY STREET, PETERBOROUGH, ONTARIO

DRAWING TITLE:

SITE PLAN -EXISTING / DEMO

PROJECT NO: 14276 SCALE: 1:150 REVIEWED BY:

PROJECT NORTH

00 Existing Site Plan



 EX. HYDRO POLE O EX. HYDRO POLE CENTERLINE OF ROADWAY NEW TREES ON MUNICIPAL MURRAY STREET RIGHT-OF-WAY, REFER TO PLANTING PLAN FX. CURB CUT RECYCLING BINS ON PICKUP DAY ONLY. EX. CONC. SIDEWALK EX. CONCRETE SIDEWALK SOD. EX. METAL FENCE ON NEIGHBOURING PROPERTY PROPERTY LINE 36.01m RIGHT-OF-WAY RIGHT-OF-WAY NEW METAL FENCE & GATE ENCLOSED PORCH 6400 CURB RAMP W. TACTILE ATTN. INDICATOR ZONE R5 ZONE R5 3 STOREY APARTMENT BUILDING 2 STOREY HOUSE 217 MURRAY STREET **NEW 3 STOREY** 14860 SHELTER SIDE SETBACK FOOTPRINT = 680m2 OUTLINE OF EXIST. BUILDING TO BE DEMOLISHED FFE GROUND FL.= 204.00 masl 3.00 m\_ SIDE SETBACE 9 PARKING SPACES + 1 BF PARKING SPACE +1 LOADING POLE MOUNTED LIGHT STANDARD W. HOUSE SIDE SHIELD. NO LIGHT SPILLAGE PAST PROPERTY LINE. ZONE R5 **■** EXIT TYPE 'B' LOADING SPACE NEW METAL FENCE -X L1 2.0m HIGH ENCLOSURE CONCRETE BLOCK W. BRICK VENEER. PRECAST CONC. CAP CONCRETE TERRACE ZONE R5 LEGEND NEIGHBOURING PROPERTY, TYP. 1 STOREY CONCRETE BUILDING SOD PLANTING BED FENCE & CONCRETE PAD W. PICNIC TABLE TYP. L2 WALL MOUNTED EXTERIOR LIGHT X SOFFIT-MOUNTED L1 EXTERIOR LIGHT SITE PLAN NOTES

. ALL SITE DIMENSIONS SHOWN IN THIS DRAWING INCLUDING BUT NOT LIMITED TO THE EXISTING BUILDING FOOTPRINTS, 1. ALL OF LOTTING AND AND AND THE THE PROPERTY LINES, SETBACKS, INFRASTRICTURE ARE TRANSPER TO FEED THE SETBACKS, PROPERTY LINES, SETBACKS, INFRASTRICTURE ARE TRANSPER TO FEED THE AND AND THE SURVEYOR OF LOT A AND PART OF LOT 5, WEST OF GEORGE STREET, SOUTH OF MIRRAY STREET, REGISTERED PLAN NO., CITY OF PETERSOROUGH, COUNTY OF PETERSOROUGH AUTHORDED WEST.

THE CONTRACTOR SHALL NOT USE THIS DRAWING TO INFER ANY SITE DIMENSIONS BUT SHALL USE THE OFFICIAL SURVEYS.

2. ALL LANDSCAPE INFORMATION ON THIS PLAN IS FOR REFERENCE ONLY. FOR ALL LANDSCAPE INFORMATION INCLUDING BUT NOT LIMITED TO TREES, SHRUBS, PERENNIALS AND ORNAMENTAL GRASSES, RETAINING WALL AND FENCING LINES SEE LANDSCAPING DRAWINGS.

3. SEE CIVL FOR SITE SERVICING AND GRADING INFORMATION.

4. ALL GEODETIC INFORMATION ON THIS PLAN IS FOR REFERENCE ONLY. THE CONTRACTOR SHALL NOT USE THIS DRAWING TO INFER ANY SITE DIMENSIONS BUT SHALL USE THE OFFICIAL SURVEYS.

#### SITE LIGHTING FIXTURES:

L1 - <u>EXTERIOR LED SOFFIT DOWNLIGHT</u>
MANUFACTURER: JUNO LIGHTING - ROUGH-IN: L4-1530U-G3, CONE: L400P-CL-WH, 1-35 WATT, OR SIMILAR.

L2 - EXTERIOR LED WALL-MOUNTED DOWN-LIGHT
MANUFACTURER: BK LIGHTING - EC-LED-E22-WFL-A9-XXX-12-C, 1-8WATT, OR SIMILAR.
NO LIGHT SPILLAGE PAST PROPERTY LINE

L3 - POLE-MOUNTED LED LIGHT STANDARD

MANUTACTURER: PHILIPS LUMEC MINIVIEW W, PHOTOCELL, 3SWATT 3500K TYPE AA WITH EXTERNAL HOUSE SHIELD. PHILIPS
SPR4 SERIES POLE & TER SERIES & BRACKET, OR SMILAR.

NO LIGHT SPILLAGE PAST PROPERTY LINE

SITE DATA	BY - LAW	EXISTING	PROPOSED
LOT AREA		2,117m2	2,117m2
LOT FRONTAGE		36 m	36 m
OFFICIAL PLAN DESIGNATION	Sched. 'A' - COMMERCIAL Sched. 'J' - COMMERCIAL CORE AREA	Sched. 'A' - COMMERCIAL Sched. 'J' - COMMERCIAL CORE AREA	Sched. 'A' - COMMERCIAL Sched. 'J' - COMMERCIAL CORE AREA
ZONING	PUBLIC SERVICE 2	PUBLIC SERVICE 2	PUBLIC SERVICE 2
USES OF THE SUBJECT LAND	PLACE OF ASSEMBLY	EMERGENCY SHELTER	EMERGENCY SHELTER & MULTI-SUITE RESIDENCE
LENGTH OF EXISTING USE	-	10 YEARS	
TYPE OF BUILDING		CHURCH / ASSEMBLY HALL	EMERGENCY SHELTER/ MULTI-SUITE RESIDENCE
DATE OF CONSTRUCTION		UNKNOWN	
SETBACKS:			
FRONT (CENTERLINE OF ST)	10m	10.15m	13.33m
REAR (LOT LINE)	BUILDING HEIGHT	24.58m	9.6m
SIDE (LOT LINE)	BUILDING HEIGHT	4.39m	3.00m
SIDE (LOT LINE)	BUILDING HEIGHT	12.18m	14.86m
BUILDING DATA:			
BUILDING CODE CLASSIFICATION		Non-conforming	Ground Floor: Group A, Division 2, up to 6 storeys, Any Area, Sprinklered
			2nd & 3rd Floor: Group C, up to 3 storeys, Sprinklered
FIRE PROTECTION			
FIRE ACCESS ROUTES REQUIRED		1	1
SPRINKLER SYSTEM FIRE ALARM REQUIRED		NOT PROVIDED YES	ENTIRE BUILDING YES
		NO NO	
STANDPIPE REQUIRED		110	NO 400 m2
GROUND FLOOR AREA		625.7m2	680 m2
GROSS FLOOR AREA		1,790m2	2,424 m2 (incl. basement)
BUILDING AREA (incl. projections)		625.7m2	820 m2
BUILDING COVERAGE RATIO (incl. projections)	40%	29.5%	38.7%
LOT COVERAGE PARKING, DRIVEWAYS, VEHICLE MOVEMENT AREAS		47% (989m2)	21% (451m2)
BUILDING HEIGHT (from average grade)	-	12.8m (Top of Roof Peak)	13.5 m 14.0 m (Top of Parapet) (Top of Mech. Penth
NUMBER OF STOREYS (above grade)		3	3
NUMBER OF DWELLING UNITS	0	0	15 (1 du /141m2)

MUNICIPAL PARKING AREA 1		NUMBER (	OF PARKING SPACE	CES
	FLOOR AREA (m2)	REQUIRED BY - LAW	EXISTING	PROPOSED
RESIDENTIAL USES:				
EMERGENCY SHELTER AREA	GROSS = 1,702 m2 NET = 952m2 # BEDS = 30	4.5 0.15 SPACES / BED	N/A	5
SINGLE RESIDENT OCCUPANCY SUITES (LIMITED KITCHEN, RELY ON COMMON DINING ROOM)	15 SUITES	15 1 SPACE / SUITE	N/A	2
COMMERICAL USES:				
OFFICE / PERSONAL SERVICE (ADMINISTRATION, CONSULTATION ROOMS, COMMUNITY ACCESS ROOMS)	GROSS = 128 m2 NET = 62m2	2.8 1 / 45m2 FLOOR AREA per Section 4.2.B.(1)	N/A	3 1 / 45m2 FLOOR ARE per Section 4.2.B.(1)
	TOTAL	23	8 UNMARKED	10 ( 13 CASH-IN-LIEU)
BARRIE	R FREE SPACES	1	UNMARKED	1
	LOADING	RESIDENTIAL = 0 per Section 4.6.2.(A).ii COMMERCIAL = 0 per Section 4.6.2.(B)1.i EMERGENCY SHELTER = 1 x 'B'	UNMARKED	1 'B' (3.6 x 6m)

1 00 Site Plan



533 College Street, Suite 301 Toronto, Ontario, Canada M6G 1A8 T: 416 203 7600 F: 416 203 3342



### ISSUED FOR SITE PLAN APPROVAL

ISSUE	DATE: SE	EPTEMBER 07, 2016
4	2016/09/07	ISSUED FOR SITE PLAN APPROVAL
3	2016/06/07	ISSUED FOR PRE-APPLICATION MTG.
2	2016/05/09	ISSUED FOR COORDINATION
1	2016/01/20	ISSUED FOR COSTING
NO.	DATE	DESCRIPTION


### **BROCK MISSION** MEN'S SHELTER


217 MURRAY STREET, PETERBOROUGH, ONTARIO

DRAWING TITLE: SITE PLAN -**PROPOSED** 

PROJECT NO: 14276 SCALE: 1:150 DRAWN BY: REVIEWED BY:

DRAWING NO:

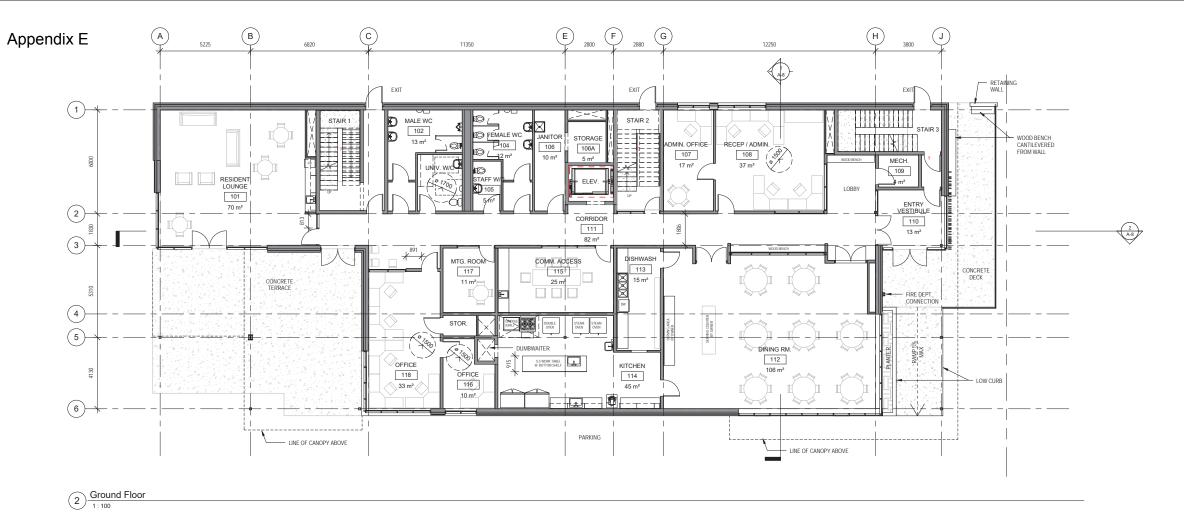

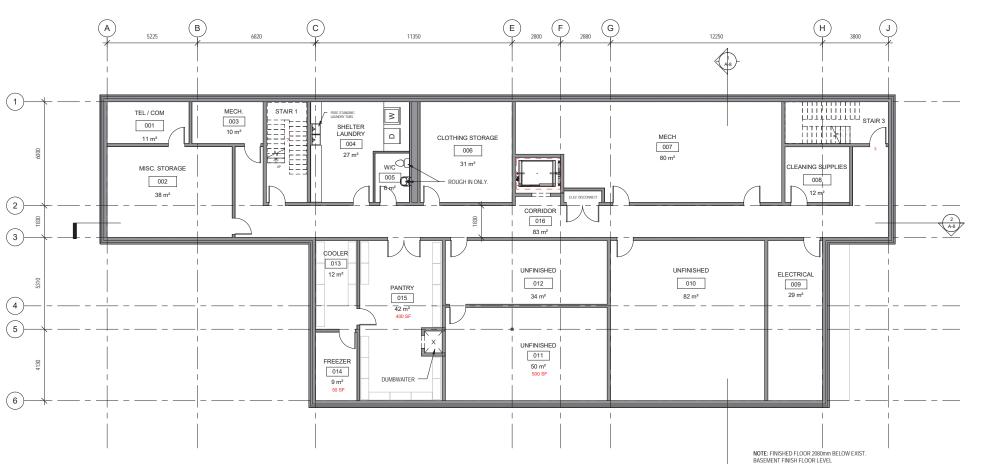

Basement 1:100

Area Schedule (Gross	Floor Area)
Level	Area (m2)
Basement F.F. (199.85masl)	680 m²
Ground Floor (204.00masl)	680 m²
Second Floor	540 m²
Third Floor	524 m²
	2,424 m²

LGA architectural partners

533 College Street, Suite 301 Toronto, Ontario, Canada M6G 1A8 T: 416 203 7600 F: 416 203 3342

NOTE: This drawing is the property of the architect and may not be reproduced used without the expressed consent of the architect. The contractor shall be responsible for checking and verifying all levels and dimensions and shall repor all discrepancies to the architect and obtain clarification prior to commencing

BUILDING PERMIT ISSUANCE SHALL BE SUBJECT TO THE BUILDING PERMIT DRAWINGS NOT BEING IN CONTRAVENTION WITH THESE APPROVED PLANS AND DRAWINGS INCLUDING, BUT NOT LIMITED TO, THE EXTERIOR DESIGN ( THE BUILDING AND EXTERIOR BUILDING MATERIALS.

#### CONTEXT PL



### ISSUED FOR SITE PLAN APPROVAL

4	2016/09/07	ISSUED FOR SITE PLAN APPROVAL
3	2016/06/07	ISSUED FOR PRE-APPLICATION MTG.
2	2016/05/09	ISSUED FOR COORDINATION
1	2016/01/20	ISSUED FOR COSTING
NO.	DATE	DESCRIPTION

### PROJECT:

# BROCK MISSION MEN'S SHELTER

217 MURRAY STREET, PETERBOROUGH, ONTARIO

### DRAWING TITLE:

SCHEMATIC FLOOR PLANS - GROUND & BASEMENT FLOORS

 PROJECT NO:
 14276

 SCALE:
 1:100

 DRAWN BY:
 AJ


 REVIEWED BY:
 JL

PROJECT NORTH

DRAWING NO:

): **2** 

**\-3** 

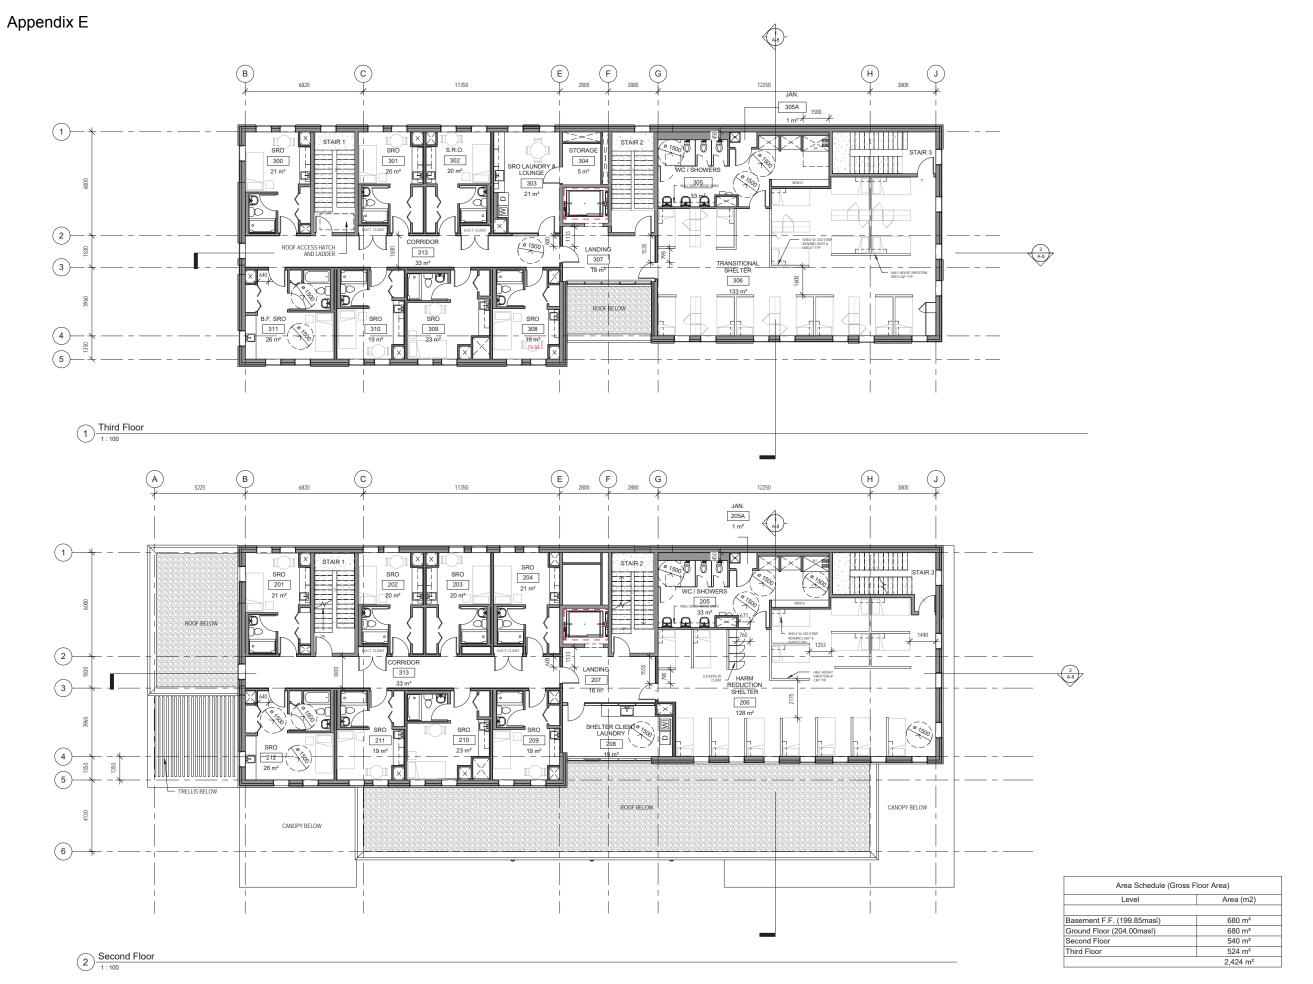

LGA architectural partners

533 College Street, Suite 301 Toronto, Ontario, Canada M6G 1A8 T: 416 203 7600 F: 416 203 3342

NOTE: This drawing is the property of the architect and may not be reproduced used without the expressed consent of the architect. The contractor shall be responsible for checking and verifying all levels and dimensions and shall repo all discrepancies to the architect and obtain clarification prior to commencing

ILLING PERMIT ISSUANCE SHALL BE SUBJECT TO THE BUILDING PERMIT AWINGS NOT BEING IN CONTRAVENTION WITH THESE APPROVED PLANS D DRAWINGS INCLUDING, BUT NOT LIMITED TO, THE EXTERIOR DESIGN OF E BUILDING AND EXTERIOR BUILDING MATERIALS.

#### CONTEXT PLAI



### ISSUED FOR SITE PLAN APPROVAL

NO.	DATE	DESCRIPTION
1	2016/01/20	ISSUED FOR COSTING
2	2016/05/09	ISSUED FOR COORDINATION
3	2016/06/07	ISSUED FOR PRE-APPLICATION MTG.
4	2016/09/07	ISSUED FOR SITE PLAN APPROVAL

### PROJECT:

## BROCK MISSION MEN'S SHELTER

217 MURRAY STREET, PETERBOROUGH, ONTARIO

### DRAWING TITLE:

SCHEMATIC FLOOR PLANS - SECOND & THIRD FLOORS


PROJECT NO:	14276
SCALE:	1:10
DRAWN BY:	AJ
DEVIEWED DV:	11

PROJECT NORTH

RAWING NO:



## Appendix E

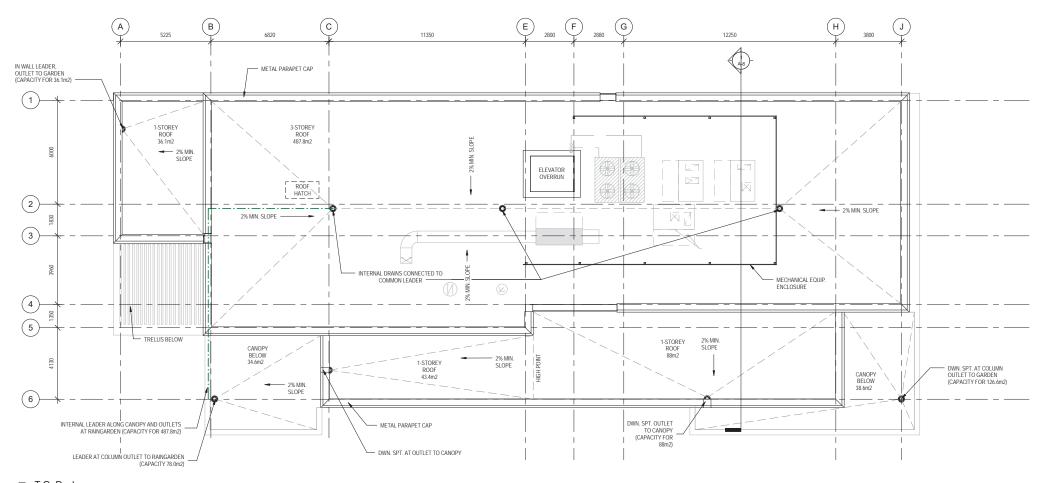

1 T.O. Deck



533 College Street, Suite 301 Toronto, Ontario, Canada M6G 1A8 T: 416 203 7600 F: 416 203 3342

NOTE: This drawing is the property of the architect and may not be reproduced used without the expressed consent of the architect. The contractor shall be responsible for checking and verifying all levels and dimensions and shall repo all discrepancies to the architect and obtain clarification prior to commencing

BUILDING PERMIT ISSUANCE SHALL BE SUBJECT TO THE BUILDING PERMI DRAWINGS NOT BEING IN CONTRAVENTION WITH THESE APPROVED PLAN AND DRAWINGS INCLUDING, BUT NOT LIMITED TO, THE EXTERIOR DESIGN THE BUILDING AND EXTERIOR BUILDING MATERIALS.

#### CONTEXT PLAI



ISSUED FOR SITE PLAN APPROVAL

ISSUE	DATE: SE	EPTEMBER 07, 2016
3	2016/09/07	ISSUED FOR SITE PLAN APPROVAL
2	2016/05/09	ISSUED FOR COORDINATION
1	2016/01/20	ISSUED FOR COSTING
NO.	DATE	DESCRIPTION

PROJEC

BROCK MISSION MEN'S SHELTER

217 MURRAY STREET, PETERBOROUGH, ONTARIO

DRAWING TITLE:

ROOF PLAN

 PROJECT NO:
 14276


 SCALE:
 1:100

 DRAWN BY:
 AJ


 REVIEWED BY:
 JL

PROJECT NORTH

RAWING NO:

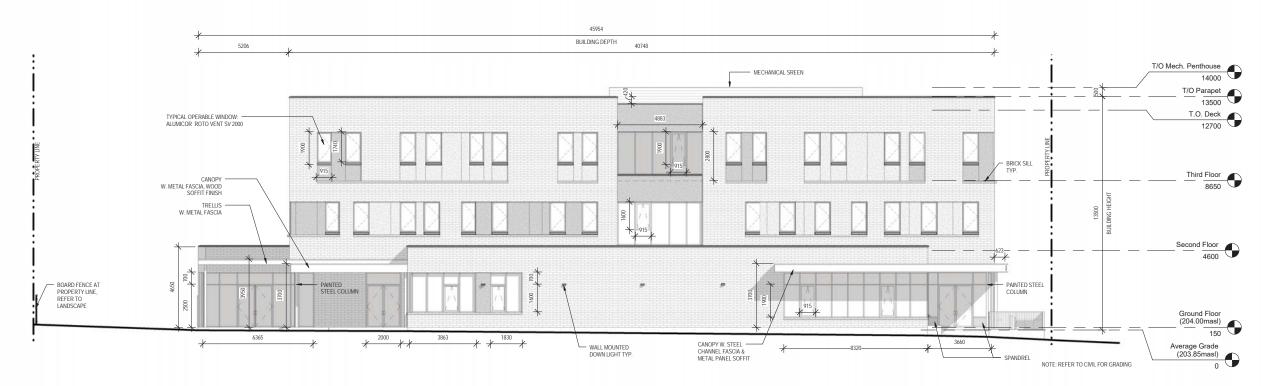

1 East Elevation

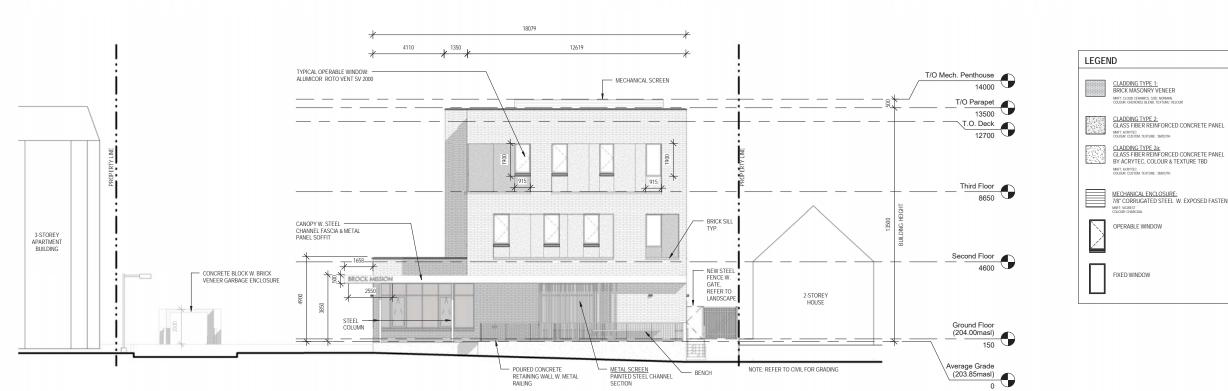

North Elevation

1:100

Legend - Elevations

1:100

LGA architectural partners

533 College Street, Suite 301 Toronto, Ontario, Canada M6G 1A8 T: 416 203 7600 F: 416 203 3342

NOTE: This drawing is the property of the architect and may not be reproduce used without the expressed consent of the architect. The contractor shall be responsible for checking and verifying all levels and dimensions and shall rep all discrepancies to the architect and obtain clarification prior to commencing

NOTE:
BUILDING PERMIT ISSUANCE SHALL BE SUBJECT TO THE BUILDING PERMIT
DRAWINGS NOT BEING IN CONTRAVENTION WITH THESE APPROVED PLANS
AND DRAWINGS INCLUDING, BUT NOT LIMITED TO, THE EXTERIOR DESIGN OF
THE BUILDING AND EXPERIOR BUILDING MATERIALS.

CONTEXT PLA



ISSUED FOR SITE PLAN APPROVAL

NO.	DATE	DESCRIPTION
1	2016/01/20	ISSUED FOR COSTING
2	2016/05/09	ISSUED FOR COORDINATION
3	2016/06/07	ISSUED FOR PRE-APPLICATION MTG.
4	2016/09/07	ISSUED FOR SITE PLAN APPROVAL

PROJECT:

BROCK MISSION MEN'S SHELTER

217 MURRAY STREET, PETERBOROUGH, ONTARIO

EXTERIOR ELEVATIONS

 PROJECT NO:
 14276

 SCALE:
 1:100


 DRAWN BY:
 AJ


 REVIEWED BY:
 JL

DRAWING NO:

South Elevation

1:100

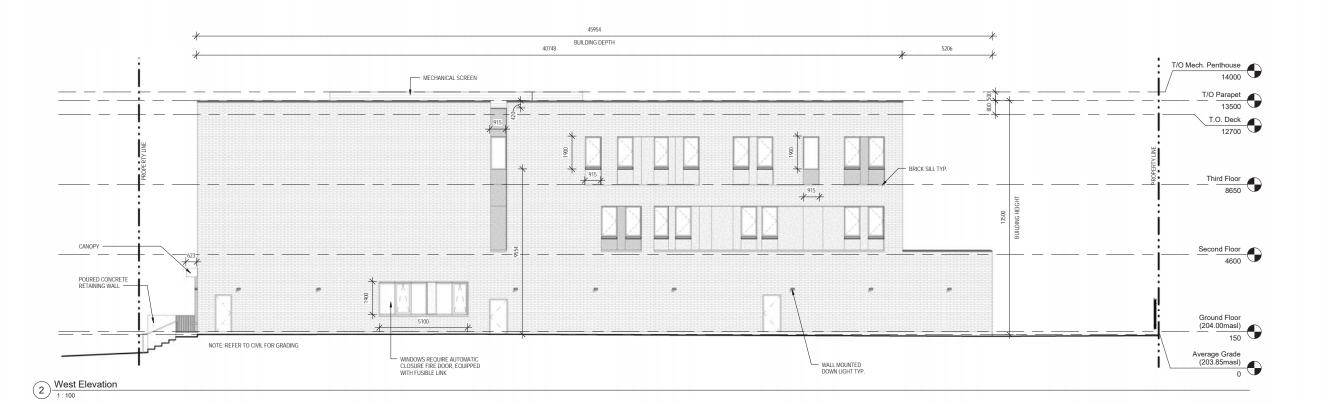

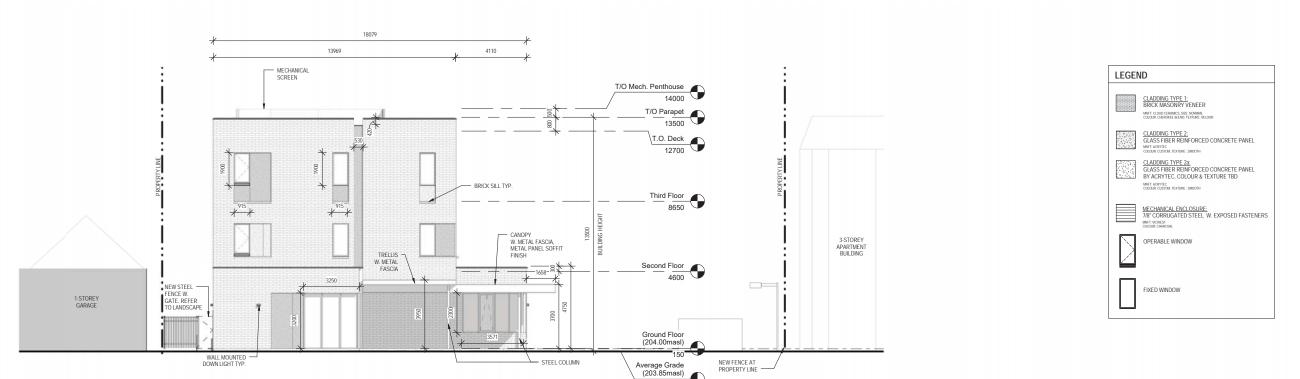

Legend - Elevations

1:100



533 College Street, Suite 301
Toronto, Ontario, Canada M6G 1A8
T: 416 203 7600 F: 416 203 3342

NOTE: This drawing is the property of the architect and may not be reproduced used without the expressed consent of the architect. The contractor shall be responsible for checking and verifying all levels and dimensions and shall report all discrepancies to the architect and obtain clarification prior to commencing

BUILDING PERMIT ISSUANCE SHALL BE SUBJECT TO THE BUILDING PERMIT DRAWINGS NOT BEING IN CONTRAVENTION WITH THESE APPROVED PLANA AND DRAWINGS INCLUDING, BUT NOT LIMITED TO, THE EXTERIOR DESIGN THE BUILDING AND EXTERIOR BUILDING MATERIALS.

#### CONTEXT PL



### ISSUED FOR SITE PLAN APPROVAL

NO.	DATE	DESCRIPTION
1	2016/01/20	ISSUED FOR COSTING
2	2016/05/09	ISSUED FOR COORDINATION
3	2016/06/07	ISSUED FOR PRE-APPLICATION MTG.
4	2016/09/07	ISSUED FOR SITE PLAN APPROVAL

PROJECT:

## BROCK MISSION MEN'S SHELTER

217 MURRAY STREET, PETERBOROUGH, ONTARIO

DRAWING TITLE:

# EXTERIOR ELEVATIONS


 PROJECT NO:
 14276

 SCALE:
 1:100


 DRAWN BY:
 Author

 REVIEWED BY:
 Checker

DRAWING N

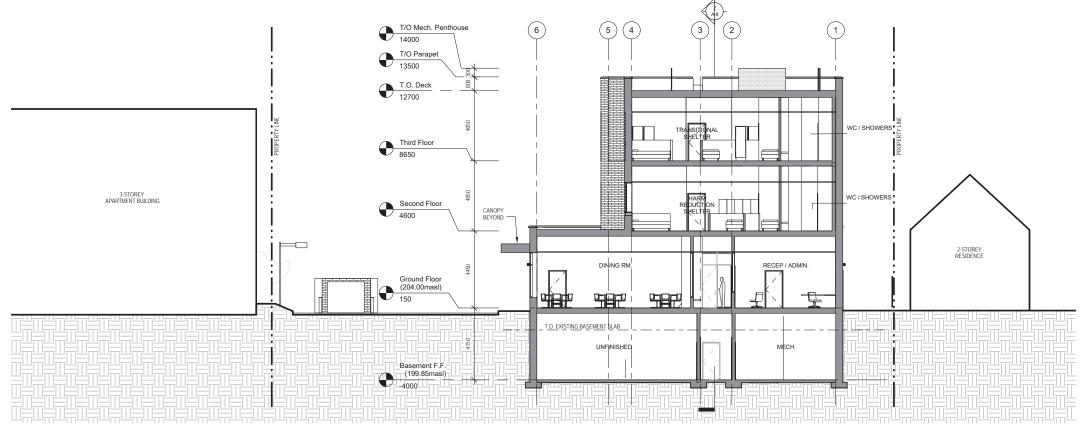

1 Building Section - East/West

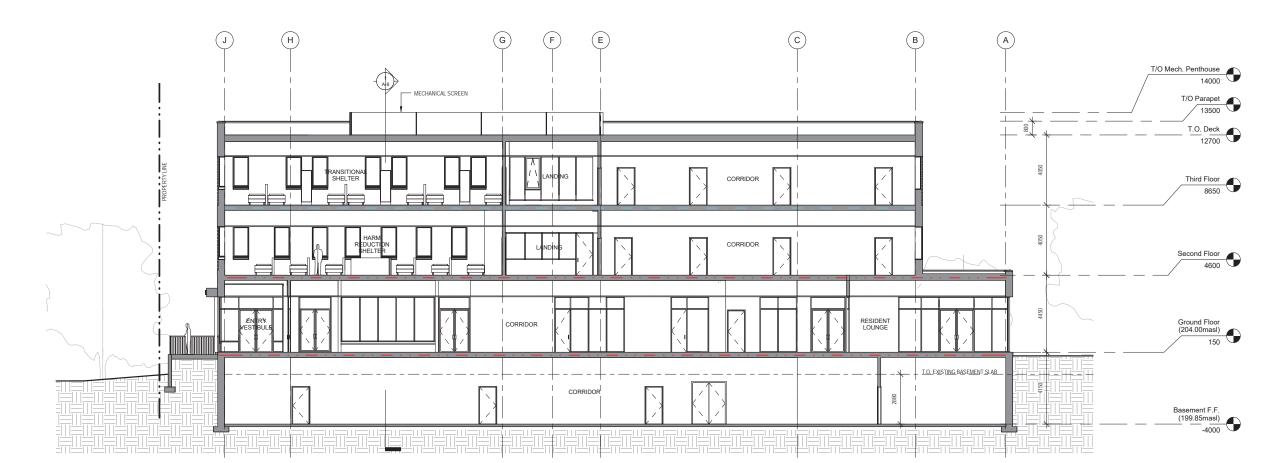

14276

DRAWING NO:

architectural partners

533 College Street, Suite 301 Toronto, Ontario, Canada M6G 1A8 T: 416 203 7600 F: 416 203 3342



### ISSUED FOR SITE PLAN APPROVAL

4	2016/09/07	ISSUED FOR SITE PLAN APPROVAL
3	2016/06/07	ISSUED FOR PRE-APPLICATION MTG.
2	2016/05/09	ISSUED FOR COORDINATION
1	2016/01/20	ISSUED FOR COSTING
NO.	DATE	DESCRIPTION

PROJECT:

## **BROCK MISSION** MEN'S SHELTER


217 MURRAY STREET, PETERBOROUGH, ONTARIO


**BUILDING SECTIONS** 

PROJECT NO: SCALE: 1:100 DRAWN BY: REVIEWED BY:

2 Building Section - North/South


## Appendix E

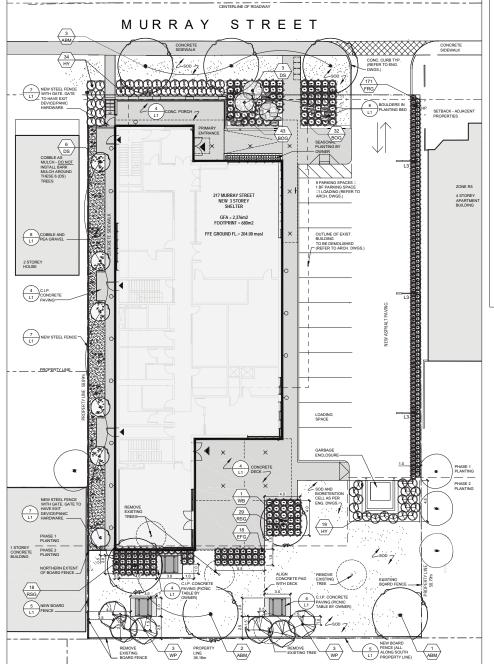

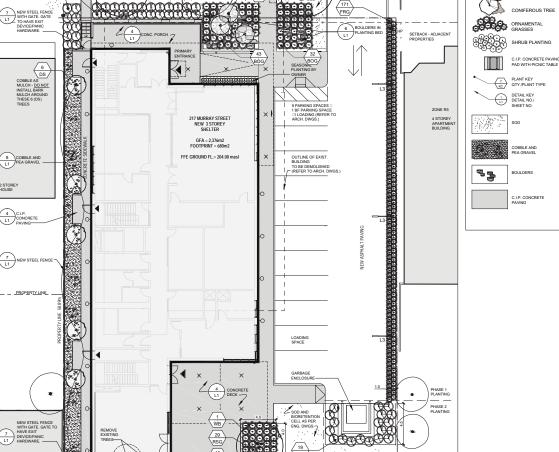



# PLANT LIST Sym | Qty | Botanical Name

LEGEND

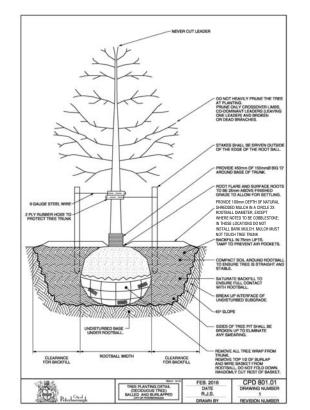


# 2 TREE PLANTING DETAIL L1 N.T.S.

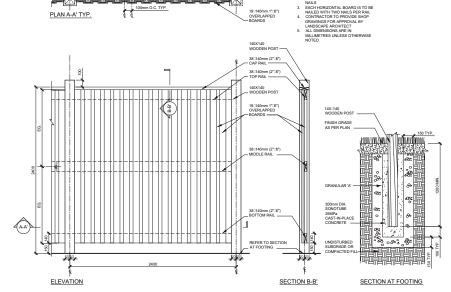


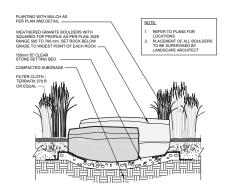

6 BOULDERS IN PLANTING BED

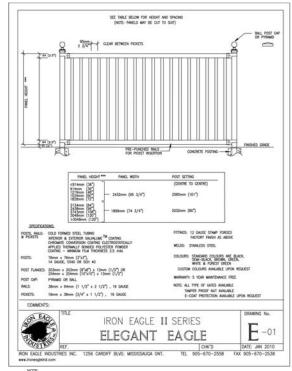

### PREFINISHED STEEL FENCE AND GATE

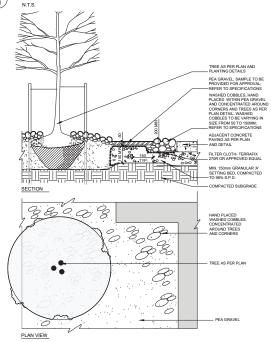

COBBLE AND PEA GRAVEL



Issued for Site Pran Application Sept.7, 2016

BROCK MISSION MEN'S SHELTER

217 MURRAY STREET, PETERBOROUGH, ONTARIO

LAND	ANDSCAPE PLAN		
Scara	1:200		
Date	JUNE 2016		
Drawn B:	ккм		
Cracked	внв		
B&A Project No.	44.20		


SHRUB PLANTING DETAIL


2. CUT AND REMOVE TOP THIRD OF BURLAP FROM ROOT BALL

LANDSCAPE PLAN

4 C.I.P. CONCRETE PAVING

BOARD FENCE
1:20

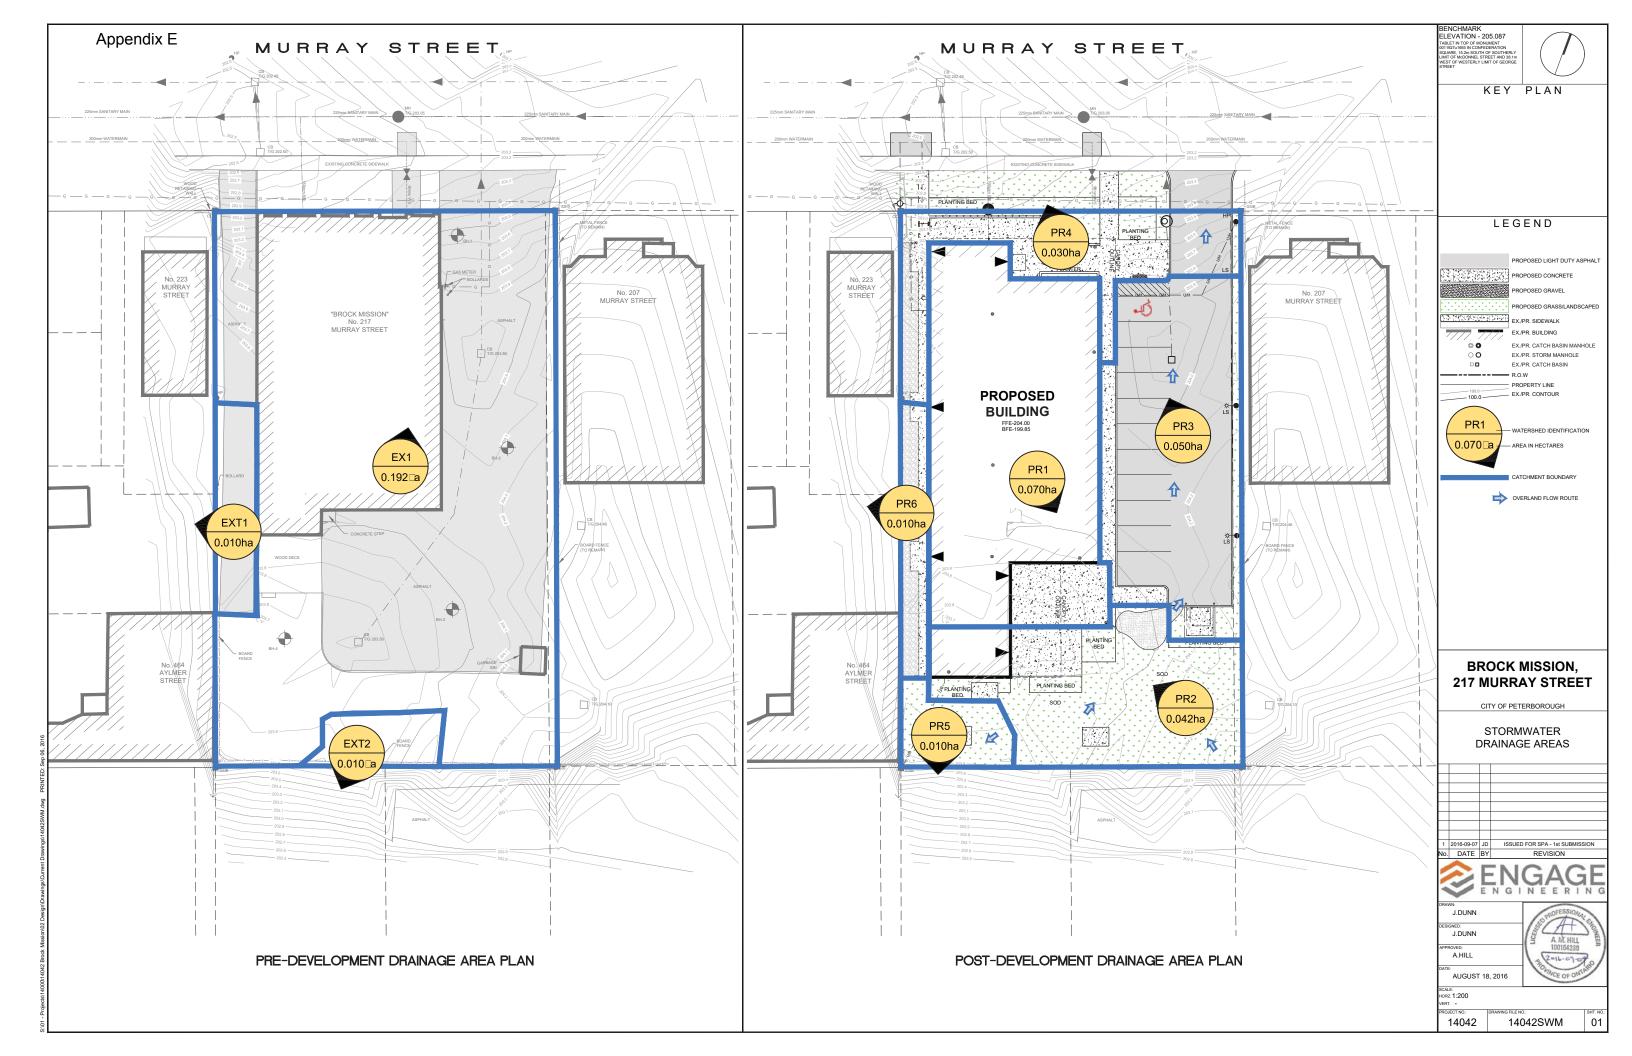

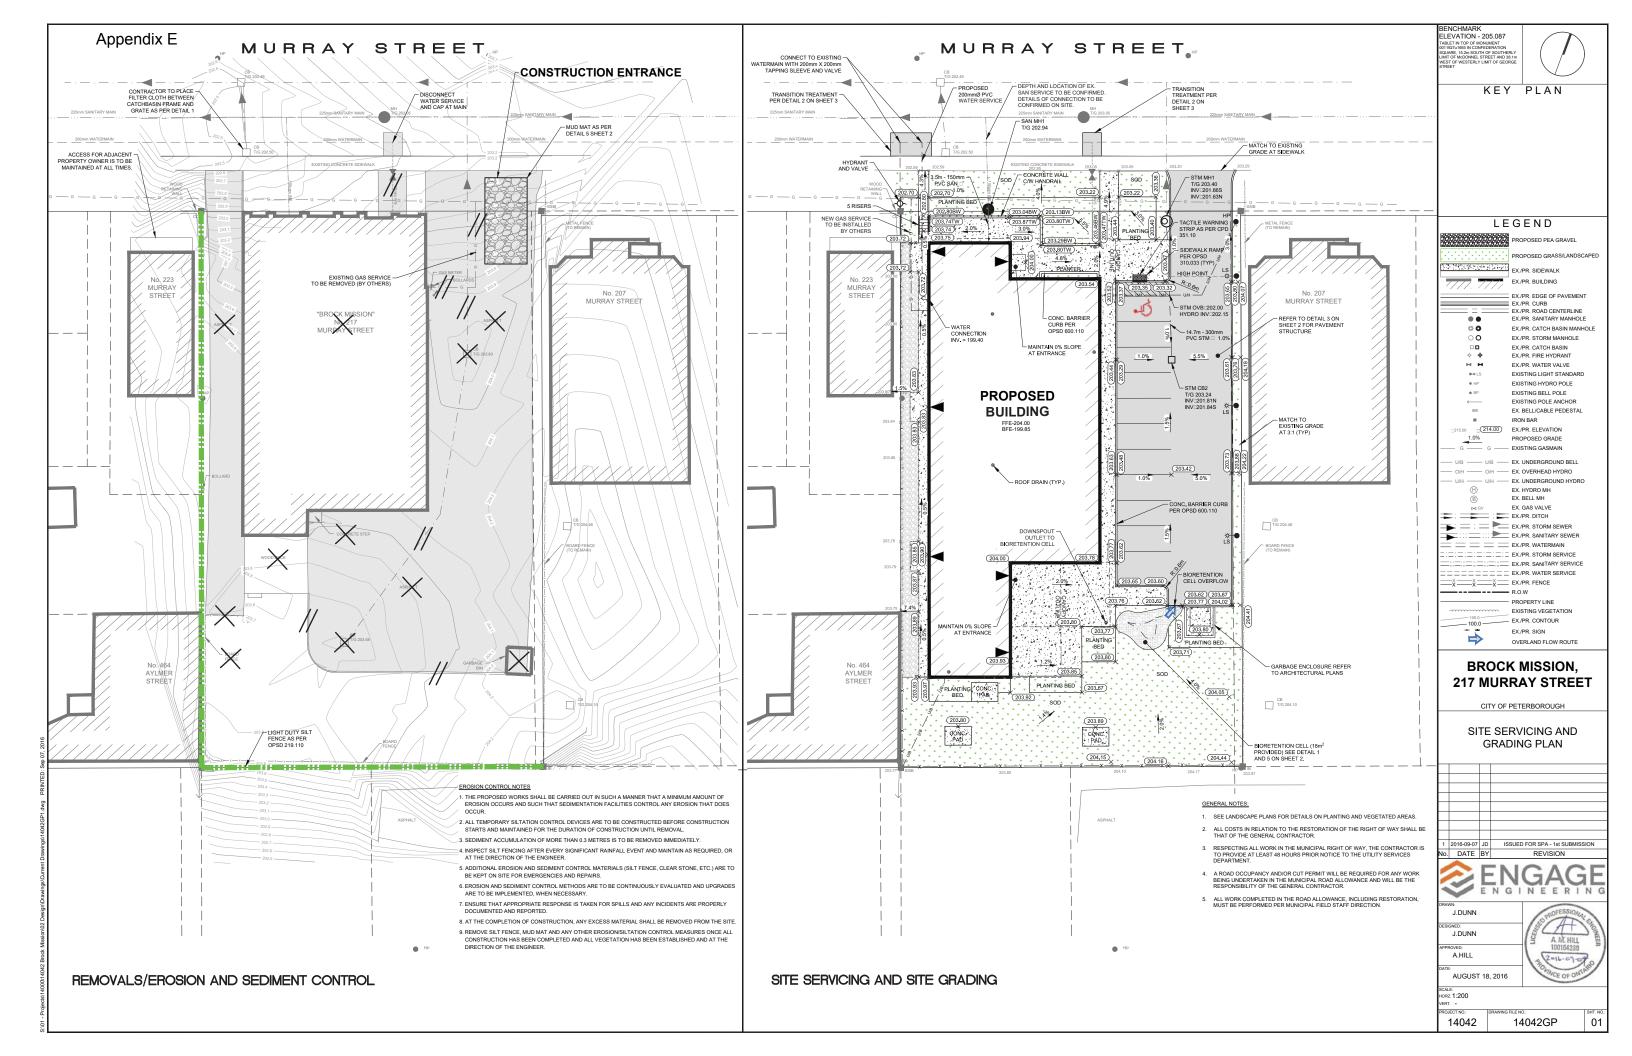

### Appendix E

### GENERAL:


- 1. ALL CONSTRUCTION AND MATERIALS TO BE IN ACCORDANCE WITH
- TERROROLIGH LITH ITIES STANDARDS ONTARIO PROVINCIAL STANDARD DRAWINGS & SPECIFICATIONS
  APPLICABLE CONTRACT DOCUMENTS AND ALL SPECIFICATIONS REFERENCED HEREIN.
- 2. THE CONTRACTOR SHALL CONSTRUCT ALL WORK IN ACCORDANCE WITH THE OCCUPATIONAL HEALTH AND SAFETY ACT, HEALTH AND SAFETY REGULATIONS FOR CONSTRUCTION PROJECTS.
- 3. THE CONTRACTOR SHALL RESTORE OR REPLACE DAMAGED SERVICES TO EXISTING OR BETTER CONDITION
- 4. THE CONTRACTOR SHALL RESTORE ALL DISTURBED AREAS TO EXISTING OR BETTER CONDITION, OR PER THE ENGINEERING AND LANDSCAPE SPECIFICATIONS REFERENCED HEREIN.
- THE CONTRACTOR SHALL COORDINATE AND PAY FOR ALL TRAFFIC CONTROL AND SAFETY MEASURES IN ACCORDANCE WITH THE ONTARIO
  TRAFFIC MANUAL, BOOK 7, TEMPORARY CONDITIONS.
- 6. THE CONTRACTOR SHALL DISPOSE OF ALL WASTE MATERIALS IN ACCORDANCE WITH THE MINISTRY OF THE ENVIRONMENT GUIDELINES AND LOCAL MUNICIPAL BYLAWS.
- WHERE UTILITIES ARE SHOWN ON THE CONTRACT DRAWINGS, THEIR LOCATION IS APPROXIMATE. THE CONTRACTOR IS RESPONSIBLE FOR VERIFYING THE LOCATION OF ALL EXISTING UTILITIES PRIOR TO CONSTRUCTION.
- THE CONTRACTOR IS RESPONSIBLE FOR OBTAINING ALL NECESSARY PERMITS TO COMPLETE THE WORK INCLUDING ROAD CUT PERMITS, OCCUPANCY PERMITS, ENCROACHMENT AGREEMENTS.
- ANY UTILITY POLES THAT MAY BE UNDERMINED BY THE CONSTRUCTION ACTIVITY ARE TO BE BRACED. THE CONTRACTOR SHALL MAKE TH NECESSARY ARRANGEMENTS TO HAVE THE POLES BRACED IN ACCORDANCE WITH THE APPROPRIATE UTILITY REQUIREMENTS; THE COST FOR THIS WORK IS INCLUDED IN THE UNIT PRICES FOR THE WORK ITEMS AFFECTED.
- 10. ALL EROSION AND SEDIMENT CONTROL MEASURES IDENTIFIED ON THE CONTRACT DRAWINGS ARE TO BE IN PLACE PRIOR TO THE START OF CONSTRUCTION.
- 11. ACCESS TO ADJACENT PRIVATE PROPERTIES SURROUNDING THE CONSTRUCTION SITE SHALL BE MAINTAINED AT ALL TIMES. TEMPORARY ACCESS RESTRICTIONS WILL ONLY BE PERMITTED WHERE REQUIRED TO FACILITATE UNDERGROUND SERVICING, ASPHALT AND CONCRETE PLACEMENT. THE CONTRACTOR SHALL PROVIDE 48 HOURS NOTICE TO THE CITY AND THE AFFECTED PROPERTY OWNERS PRIOR TO ACCESS NTERRUPTION. GENERAL CONTRACTOR MUST MAINTAIN ACCESS FOR PETERBOROUGH HOUSING RESIDENCE AND SERVICE VEHICLES THROUGHOUT CONSTRUCTION.
- 12. ALL PROPERTY BARS DISTURBED OR DAMAGED DURING CONSTRUCTION SHALL BE REPLACED BY THE CONTRACTOR AT THE CONCLUSION OF THE CONTRACT, AT THEIR EXPENSE.
- 13. ALL MANHOLE AND CATCHBASIN FRAMES AND GRATES WITHIN THE TRAVELED PORTION OF THE ROAD SHALL BE SET TO BASE ASPHALT ELEVATION AND RAISED PRIOR TO PLACEMENT OF SURFACE ASPHALT.

- 19. A ROAD OCCUPANCY AND/OR CUT PERMIT WILL BE REQUIRED FOR ANY WORK BEING UNDERTAKEN IN THE MUNICIPAL ROAD ALLOWANCE


## (203.65) 203.80 CONCRETE SIDEWALK 203.76 (203.73 (203.72) 203.55 (203.65) 203.55 (203.55) 0.0% 203.72 203.55 203.76 V (203.79) 203.81 **BIORETENTION CELL DETAIL** 5 SCALE: 1:50

#### STORM SEWER AND WATERMAIN:


- THE CONTRACTOR SHALL INSTALL PRECAST CONCRETE MANHOLES AS PER OPSD 701.010 AND OPSD 401.010 RESPECTIVELY UNLESS OTHERWISE SPECIFIED ON THE DRAWINGS.
- THE CONTRACTOR SHALL INSTALL PRECAST CONCRETE CATCH BASIN MANHOLES AS PER OPSD 701.010 AND OPSD 400.020 RESPECTIVELY UNLESS OTHERWISE SPECIFIED ON THE DRAWINGS.
- 3. THE CONTRACTOR SHALL INSTALL DOUBLE CATCHBASINS MANHOLES COMPLETE WITH FRAME, GRATE AS PER OPSD 701.0110 AND OPSD 400.020 RESPECTIVELY UNLESS OTHERWISE SPECIFIED ON THE DRAWINGS.
- 4. ALL AREA DRAINS ARE TO BE WATTS CANADA MODEL FD-340.
- THE CONTRACTOR SHALL INSTALL SUBDRAIN PIPE UNDER CONCRETE CURB AND PAVEMENT STRUCTURE AS PER OPSD 216.021, UNLESS OTHERWISE SPECIFIED ON THE DRAWINGS.
- 6. THE CONTRACTOR SHALL PERFORM LEAK AND DEFLECTION TESTING ON ALL STORM SEWERS IN ACCORDANCE WITH CONTRACT DOCUMENTS AND OPSS 410 RESPECTIVELY.
- 7. THE CONTRACTOR SHALL CLEAN AND PERFORM CCTV INSPECTION ON ALL STORM SEWERS IN ACCORDANCE WITH CONTRACT DOCUMENTS AND OPSS 409 RESPECTIVELY.
- 8. THE CONTRACTOR SHALL PROVIDE 48 HOURS NOTICE TO THE ENGINEER PRIOR TO CONDUCTING PIPE LEAK AND DEFLECTION TESTING CCTV INSPECTIONS AND/OR CLEANING OF THE STORM SEWER.
- PIPE BEDDING, COVER AND BACKFILL SHALL BE IN ACCORDANCE WITH THE OPSD 802.010 FOR FLEXIBLE PIPE AND OPSD 802.030 FOR
  CONCRETE PIPE. BEDDING AND COVER SHALL BE GRANULAR 'A' COMPACTED TO 100 % SPDD; BACKFILL SHALL BE NATIVE MATERIAL OR
  GRANULAR 'B'; COMPACTED TO 100 % SPDD.
- 10. ALL STORM MANHOLES SHALL BE BENCHED IN ACCORDANCE WITH OPSD 701.021. ALL CATCHBASINS SHALL HAVE A MINIMUM 0.6m SUMP

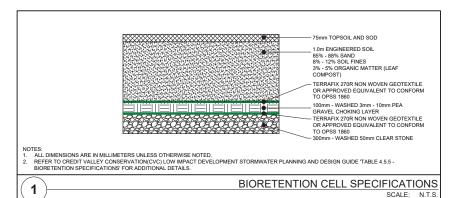

PARKING LOT PAVEMENT STRUCTURE

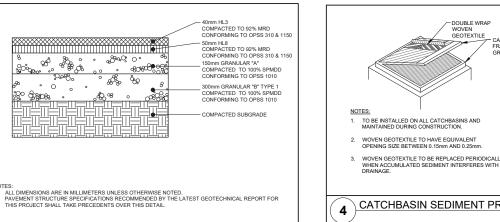

SCALE: N.T.S

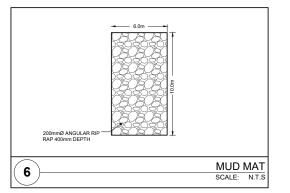


3

### SURVEY:


- 1. EXISTING UNDERGROUND SERVICES, UTILITIES, AND TOPOGRAPHIC INFORMATION IS BASED UPON:
- TOPOGRAPHIC SURVEY PROVIDED BY BENINGER SURVEYORS, JOB No. 25133-T DATED OCTOBER 21, 2009.
- LEGAL BOUNDARY INFORMATION PROVIDED BY BENINGER SURVEYORS, JOB No. 25133-T DATED OCTOBER 21, 2009.
- 2. THE CONTRACTOR SHALL PROVIDE DETAILED LAYOUT FOR THE WORK INCLUDING CALCULATIONS OF LAYOUT DIMENSIONS AND ELEVATIONS.
- THE CONTRACTOR SHALL PROVIDE AN AUTOCAD DIGITAL FILE AND ACCOMPANYING HARDCOPY OF THE AS CONSTRUCTED SERVICING AND SITE GRADING. THE DRAWINGS SHALL CONVEY ALL UNDERGROUND SERVICING AND INFRASTRUCTURE BASED ON TOPOGRAPHIC SURVEY

### **ROADS**

- 1. IN AREAS WHERE PARKING OR ENTRANCEWAY ARE PROPOSED SUBEXCAVATION TO 1.5m BELOW GRADE IS REQUIRED. THE SUBGRADE AT 1.5mbeg SHOULD BE COMPACTED AND BUILT BACK UP WITH EXCAVATED MATERIAL. EXCAVATED MATERIAL CONTAINING ORGANICS, ASH, COAL TAR, BRICKS, ETC. SHOULD NOT BE USED TO BUILD GRADE UP TO BASE OF GRANULARS. GEOTEXTUM YES REQUIRED ON CERTAIN AREAS OF THE SUBGRADE AS DIRECTED BY THE GEOTECHNICAL ENGINEER. RECOMMENDATIONS IN THE LATEST GEOTECHNICAL REPORT SHALL TAKE PRECEDENTS OVER THIS NOTE.

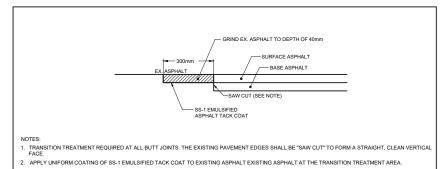

ASPHALT TRANSITION TREATMENT 2

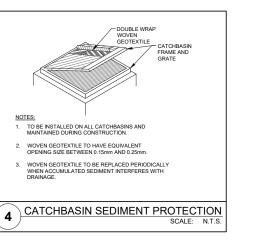

ONTARIO PROVINCIAL STANDARDS

OPSD-219.110 OPSD-400.020

OPSD-405.020

OPSD-600.110

OPSD-701.010

OPSD-701 030

OPSD-705.010 OPSD-802.010

OPSS-805 (NOV 2010

OPSS-407 (NOV 2014) OPSS-402 (NOV 2013)

OPSS-407 (NOV 2014) OPSS-353 (NOV 2010)

OPSS-407 (NOV 2014) OPSS-402 (NOV 2013) OPSS-407 (NOV 2014)

OPSS-407 (NOV 2014) OPSS-402 (NOV 2013) OPSS-410 (NOV 2013)

OPSS-410 (NOV 2013)

OPSS-1010 (APR 2013)

LIGHT DUTY SILT FENCE CATCH BASIN AND CATCH BASIN MANHOLE FRAME AND GRATE

MAINTENANCE HOLE, SQUARE FRAME, CIRCULAR

1200mm PRECAST MANHOLE COMPONENTS

MATERIAL SPECIFICATIONS FOR AGGREGATES

FLEXIBLE PIPE EMBEDMENT AND BACKFILL EARTH EXCAVATION


CONSTRUCTION/MATERIAL SPECIFICATIONS FOR HOT MIX ASPHALT


RIGID PIPE EMBEDMENT AND BACKFILL EARTH EXCAVATION TYPE 1 OPSD-802.030

PRECAST CONCRETE CATCH BASIN

OR 2 SOIL

CONCRETE SIDEWALK

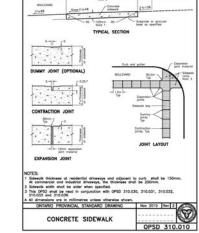

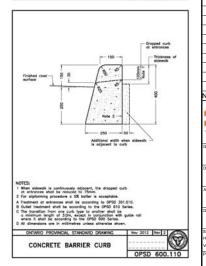

ENCHMARK LEVATION - 205.087



KEY PLAN

LEGEND

**BROCK MISSION, 217 MURRAY STREET** 

CITY OF PETERBOROUGH

**GENERAL NOTES** AND DETAILS



AUGUST 18, 2016 z. AS NOTED

14042 14042GP

02

